## ISUROON HEADQUARTERS

1600 E Lake St, Minneapolis, MN 55407



Architecture
Interior Design
Landscape

222 North Second Street Long & Kees Bldg Suite 101 Minneapolis, MN

612.339.3752

www.bkvgroup.com


CONSULTANTS

PROJECT TITLE

ISUROON

ISSUE # DATE DESCRIPTION
1 03/23/2022 SCHEMATIC DESIGN



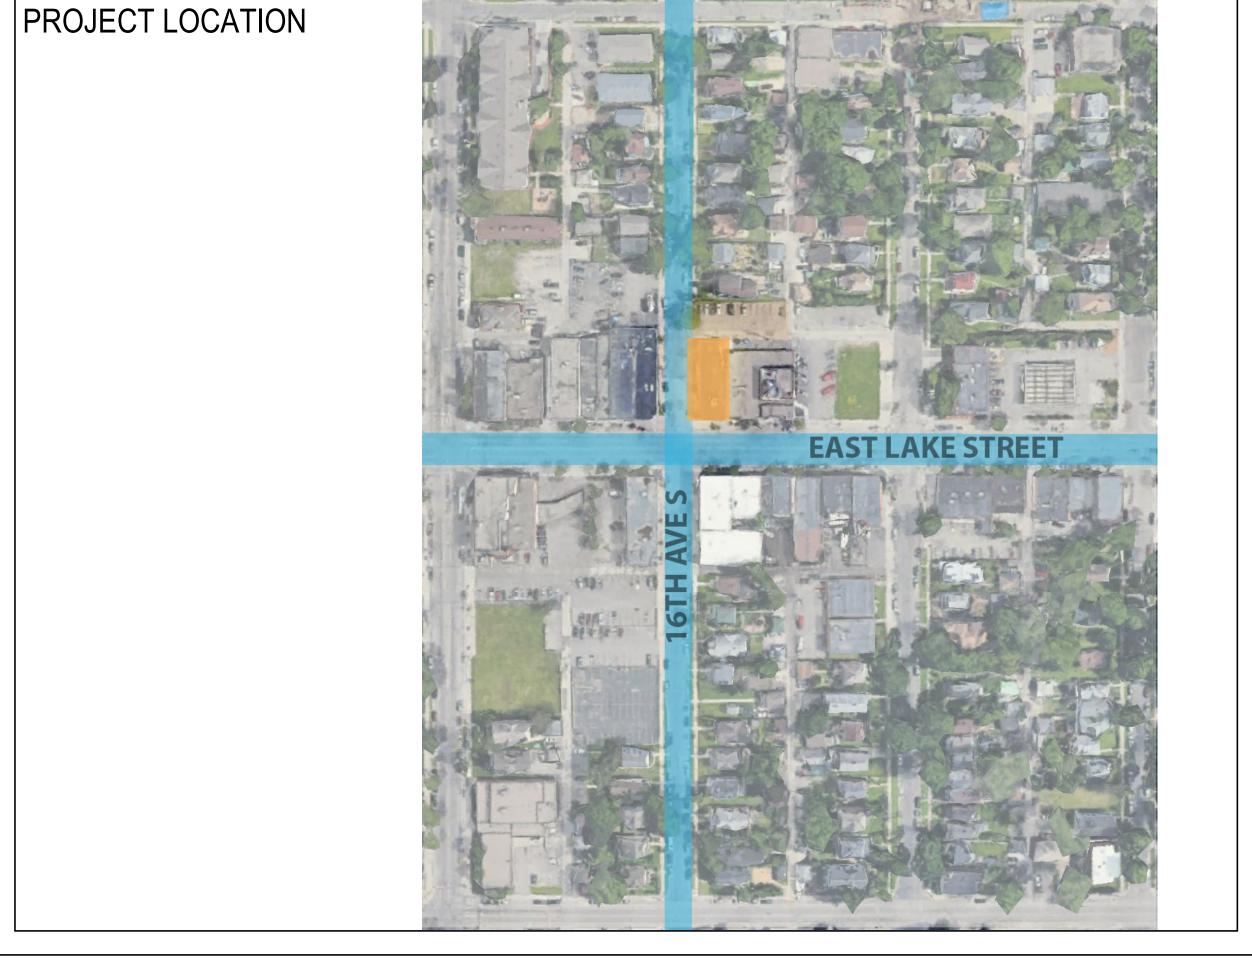



PROJECT TEAM			
OWNER / APPLICANT:			
Isuroon			
1600 E Lake St Suite 1,			
Minneapolis, MN 55407			
Phone: 952.564.1131			
Contact: Fartun Weli			
Architect:			
Boarman Kroos Vogel Group, Inc			
222 North Second Street			
Minneapolis, Minnesota 55401			
Phone: 612.339.3752			
Fax: 612.339.6212			
Contact: Ellie Ziaie			
Structural Engineering:			
Boarman Kroos Vogel Group, Inc			
222 North Second Street			
Minneapolis, Minnesota 55401			
Phone: 612.339.3752			
Fax: 612.339.6212			
Contact: Kyle Olson			
Mechanical Engineering:			
Boarman Kroos Vogel Group, Inc			
222 North Second Street			
Minneapolis, Minnesota 55401			
Phone: 612.339.3752			
Fax: 612.339.6212			
Contact: Alex Sawka			
Electrical Engineering:			
Boarman Kroos Vogel Group, Inc			
222 North Second Street			
Minneapolis, Minnesota 55401			
Phone: 612.339.3752			
Fax: 612.339.6212			
Contact: Chad Kurdi			

CERTIFICATION

CONSTRUCTION

DRAWN BY Author
CHECKED BY Checke
COMMISSION NUMBER 2508.01
SHEET TITLE

**COVER SHEET** 

SHEET NUMBER

G100

21 BKV Group

BIM 360://2508-01 Isuroon\_AI\_2021/2508-01\_Isuroon\_AI\_202

RENDERING

BKV

Isuroon Minneapolis, MN BKV Project No.: 2508.01

7 Fire Draft Stops

8 Means of Egress

Occupant Load

10 Fire Extinguisher

12 Accessibility

1 Interior Finish Ratings

75% @ 15' < X < 20'

No Limit @ X > 20'

Exit Door (Minimum)

Corridor (Minimum)

Provide in compliance with IBC 718.

Exit Element

Guard Height (Minimum)

Exit Access Travel Distance (B)

Occupant Load is 69 for first floor

ccupancy of lower level (not included in scope) will not change

END OF CODE SUMMARY

or Occupancy Group B

Rooms, enclosed spaces

Rooms, enclosed spaces

struction will be re-installed as original.

Common Path of Egress Distance B = 75'

NOTE: Any Fire Blocking or Draft Stopping that is removed during con-

Provide Fire Extinguishers in compliance with NFPA Chapter 10.

sota Accessibility Code.

36" (3'-0")

42" (3'-6")

All public use areas are required to be designed

and constructed to comply with the 2020 Minne-

BKV

Dimension

44" (3'-8") - maintain 22" beyond

projection of in-swinging door

## CODE SUMMARY

**GOVERNING CODES, LAWS & AGENCIES:** 2020 Minnesota Conservation Code for Existing Buildings

- 2020 Minnesota Accessibility Code 2020 Minnesota Mechanical Code and Fuel Gas Code
- 2020 Minnesota State Plumbing Code 2020 Minnesota State Fire Code
- 2020 National Electrical Code

Scope of work is defined as follows:

There will be no change of occupancy from an existing Group B – Business.

 Alteration to the interior of the first floor including the following: Demolition of interior partitions and ceilings.

Construction of new partitions and ceiling. Addition of 3 accessible single user restrooms, and a single non-accessible restroom in a private office.


- Level 3 Alteration. Reconfiguration of partitions and modifications to all building systems; electrical, mechanical, and plumbing.
- Roof tear off to existing deck and replace with new membrane roof system.
- Repoint chimney.

Code Summary

1	Occupancy Classification	Primary Occupancy: B (Office)
	(Existing Building)	Accessory Occupancy: S-2 (Storage)
2	Type of Construction	Building is assumed to meet the requirements for Type V-B Construc-
	(Existing Construction)	tion.
3	Allowable Area	Type V-B
		Building is existing and complies with Allowable Area for Type V-B
		Construction
4	Allowable Height	Type V-B
		Building is existing and complies with Allowable Stories and Height
		Based Type V-B Construction
5	Fire Resistance of Build-	Type V-B
	ing Elements:	The existing building is not sprinkled.
6	Opening Protection	Not Permitted @ X < 3'
		15% @ 3' < X < 5'
		25% @ 5' < X < 10'
		45% @ 10' < X < 15'

Code Summary

CS - 1

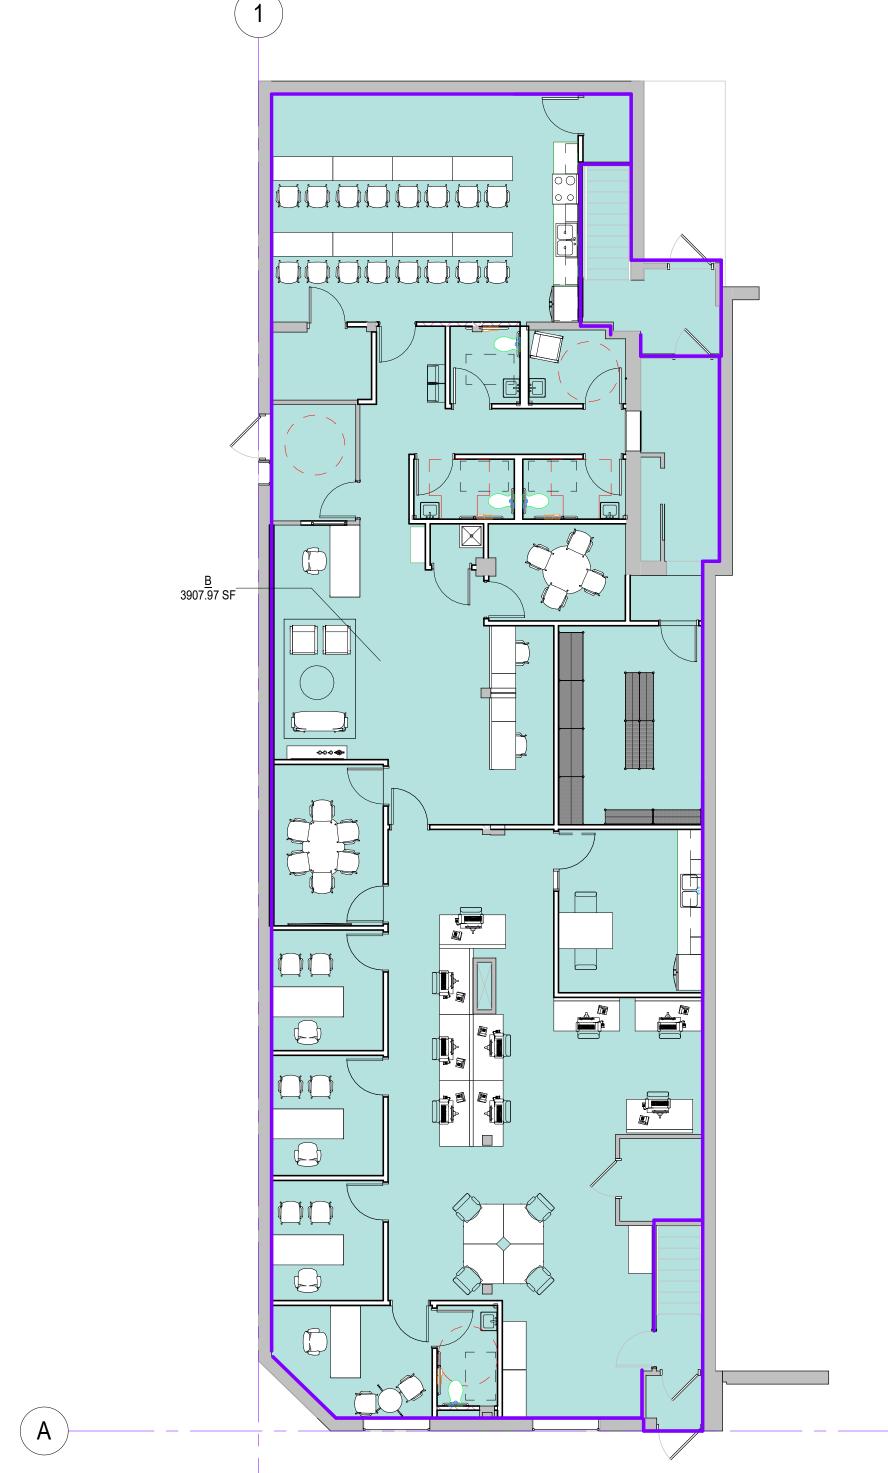

3 LEVEL 1 - OCCUPANCY PLAN
G120 1/8" = 1'-0"


## OCCUPANCY CLASSIFCATION

CS - 2

\*GSF AREA BY BUILDING BY... Level Area

3448.21 SF 6755.70 SF TOTAL GSF 6755.70 SF

\*GSF AREA BY BUILDING BY.. 3907.97 SF

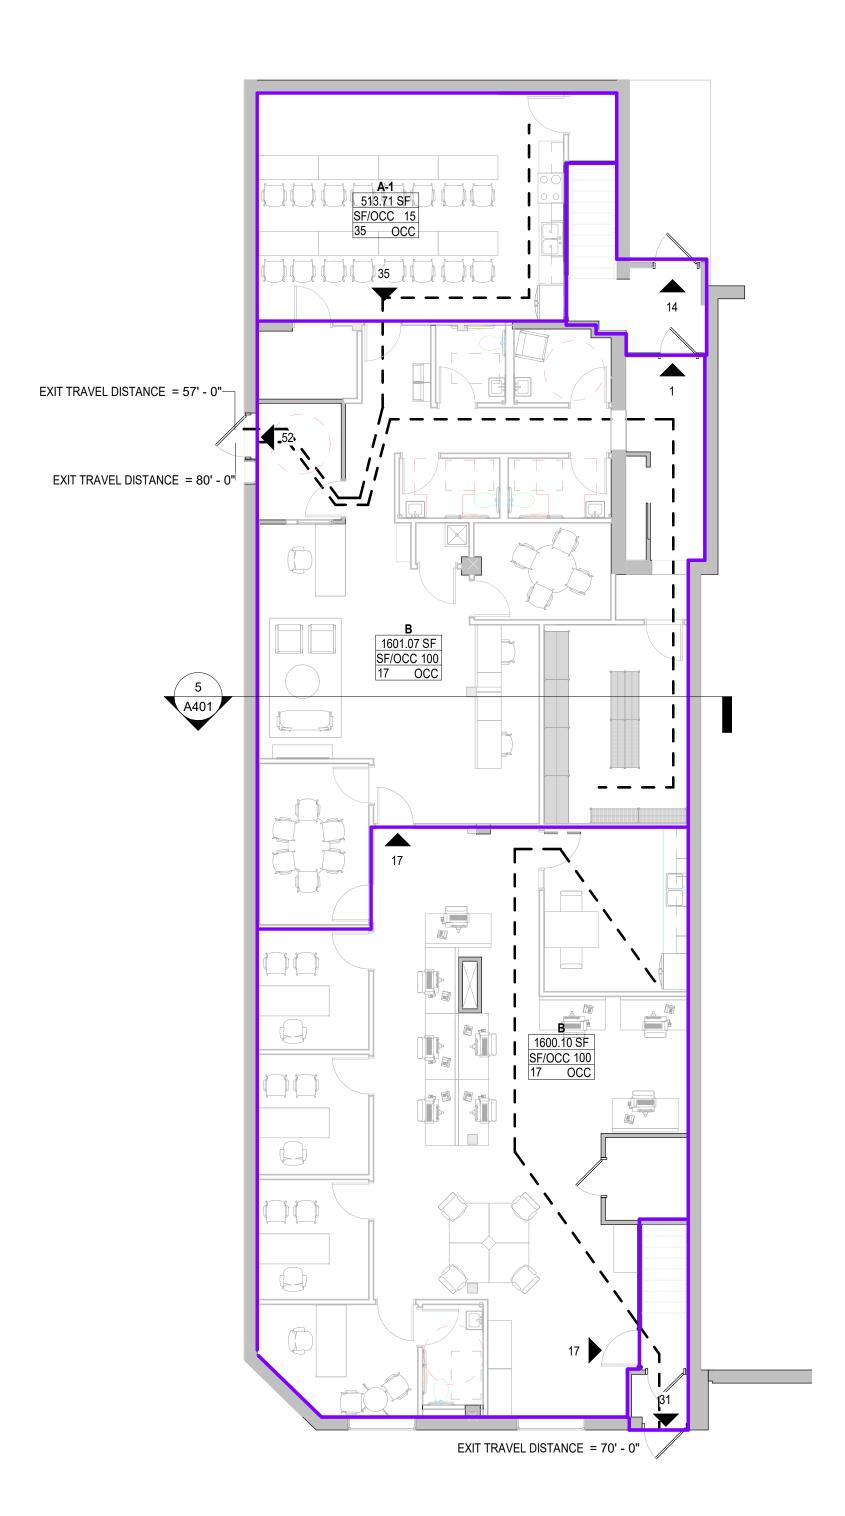

2 LEVEL 1 - CODE PLAN
G120 1/8" = 1'-0"

Architecture Interior Design Landscape Architecture

222 North Second Street Long & Kees Bldg Suite 101 Minneapolis, MN

612.339.3752

www.bkvgroup.com

**CONSULTANTS** 

PROJECT TITLE

1 03/23/2022 SCHEMATIC DESIGN

STANDPIPE FIRE EXTINGUISHER: SEE FLOOR PLANS FOR FIRE EXTINGUISHER TYPES AND LOCATIONS ---- EXIT TRAVEL DISTANCE NUMBER OF OCCUPANTS EXITING OCCUPANT LOAD LIFE SAFETY ROOM TAG: Name INDICATES ROOM NAME ■ INDICATES ROOM NUMBER 150 SF
SF/OCC 20
INDICATES ROOM SQUARE FOOTAGE
INDICATES SQUARE FOOTAGE PER OCCUPANT
INDICATES OCCUPANT LOAD

SEPARATED OCCUPANCY

CODE LEGEND

LIFE SAFETY PLAN NOTES:

1. LIFE SAFETY PLANS ARE INTENDED TO BE PRINTED IN COLOR FOR CLARITY.

2. HIGHEST REQUIRED HOURLY RATING FOR ANY INDIVIDUAL WALL WILL BE SHOWN IN A-SHEETS WHERE MULTIPLE REQUIRED RATINGS OCCUR BASED ON LIFE SAFETY

AND CONSTRUCTION TYPE.

3. EXIT ACCESS TRAVEL DISTANCE PER IBC 1016.1 IS 250 FEET AT R-2, 400 FEET AT S-2. 4. MAXIMUM TRAVEL DISTANCE TO FIRE EXTINGUSHER PER IFC 906.3 IS 75 FEET.

5. SEE SHEET G110 FOR COMPLETE CODE SUMMARY 6. PROVIDE 2-WAY COMMUNICATION AT ELEVATOR LOBBIES PER IBC 1007.8.

7. ALL DWELLING UNITS ARE MN STATE ACCESSIBILITY TYPE B PER CODE, CHAPTER

1341 UNLESS NOTED OTHERWISE.
8. SEE SHEETS G131 AND G132 FOR BEARING WALL LOCATIONS AND STRUCTURAL MEMBERS REQUIRING CONSIDERATION OF INDIVIDUAL PROTECTION PER IBC 704

(SEE STRUCTURAL FOR ADDITIONAL INFORMATION)
9. ASSEMBLY OCCUPANT LOADS SHALL BE POSTED BY SIGNAGE AT TIME OF FINAL **BUILDING INSPECTION** 

PROVIDE IDENTIFICATION MARKINGS ON ALL WALLS REQUIRED TO HAVE PROTECTED OPENINGS OR PENETRATIONS PER MBC 703.7.

CERTIFICATION


CHECKED BY COMMISSION NUMBER SHEET TITLE

CODE SUMMARY & LIFE SAFETY PLAN

SHEET NUMBER

G120

© 2021 BKV Group

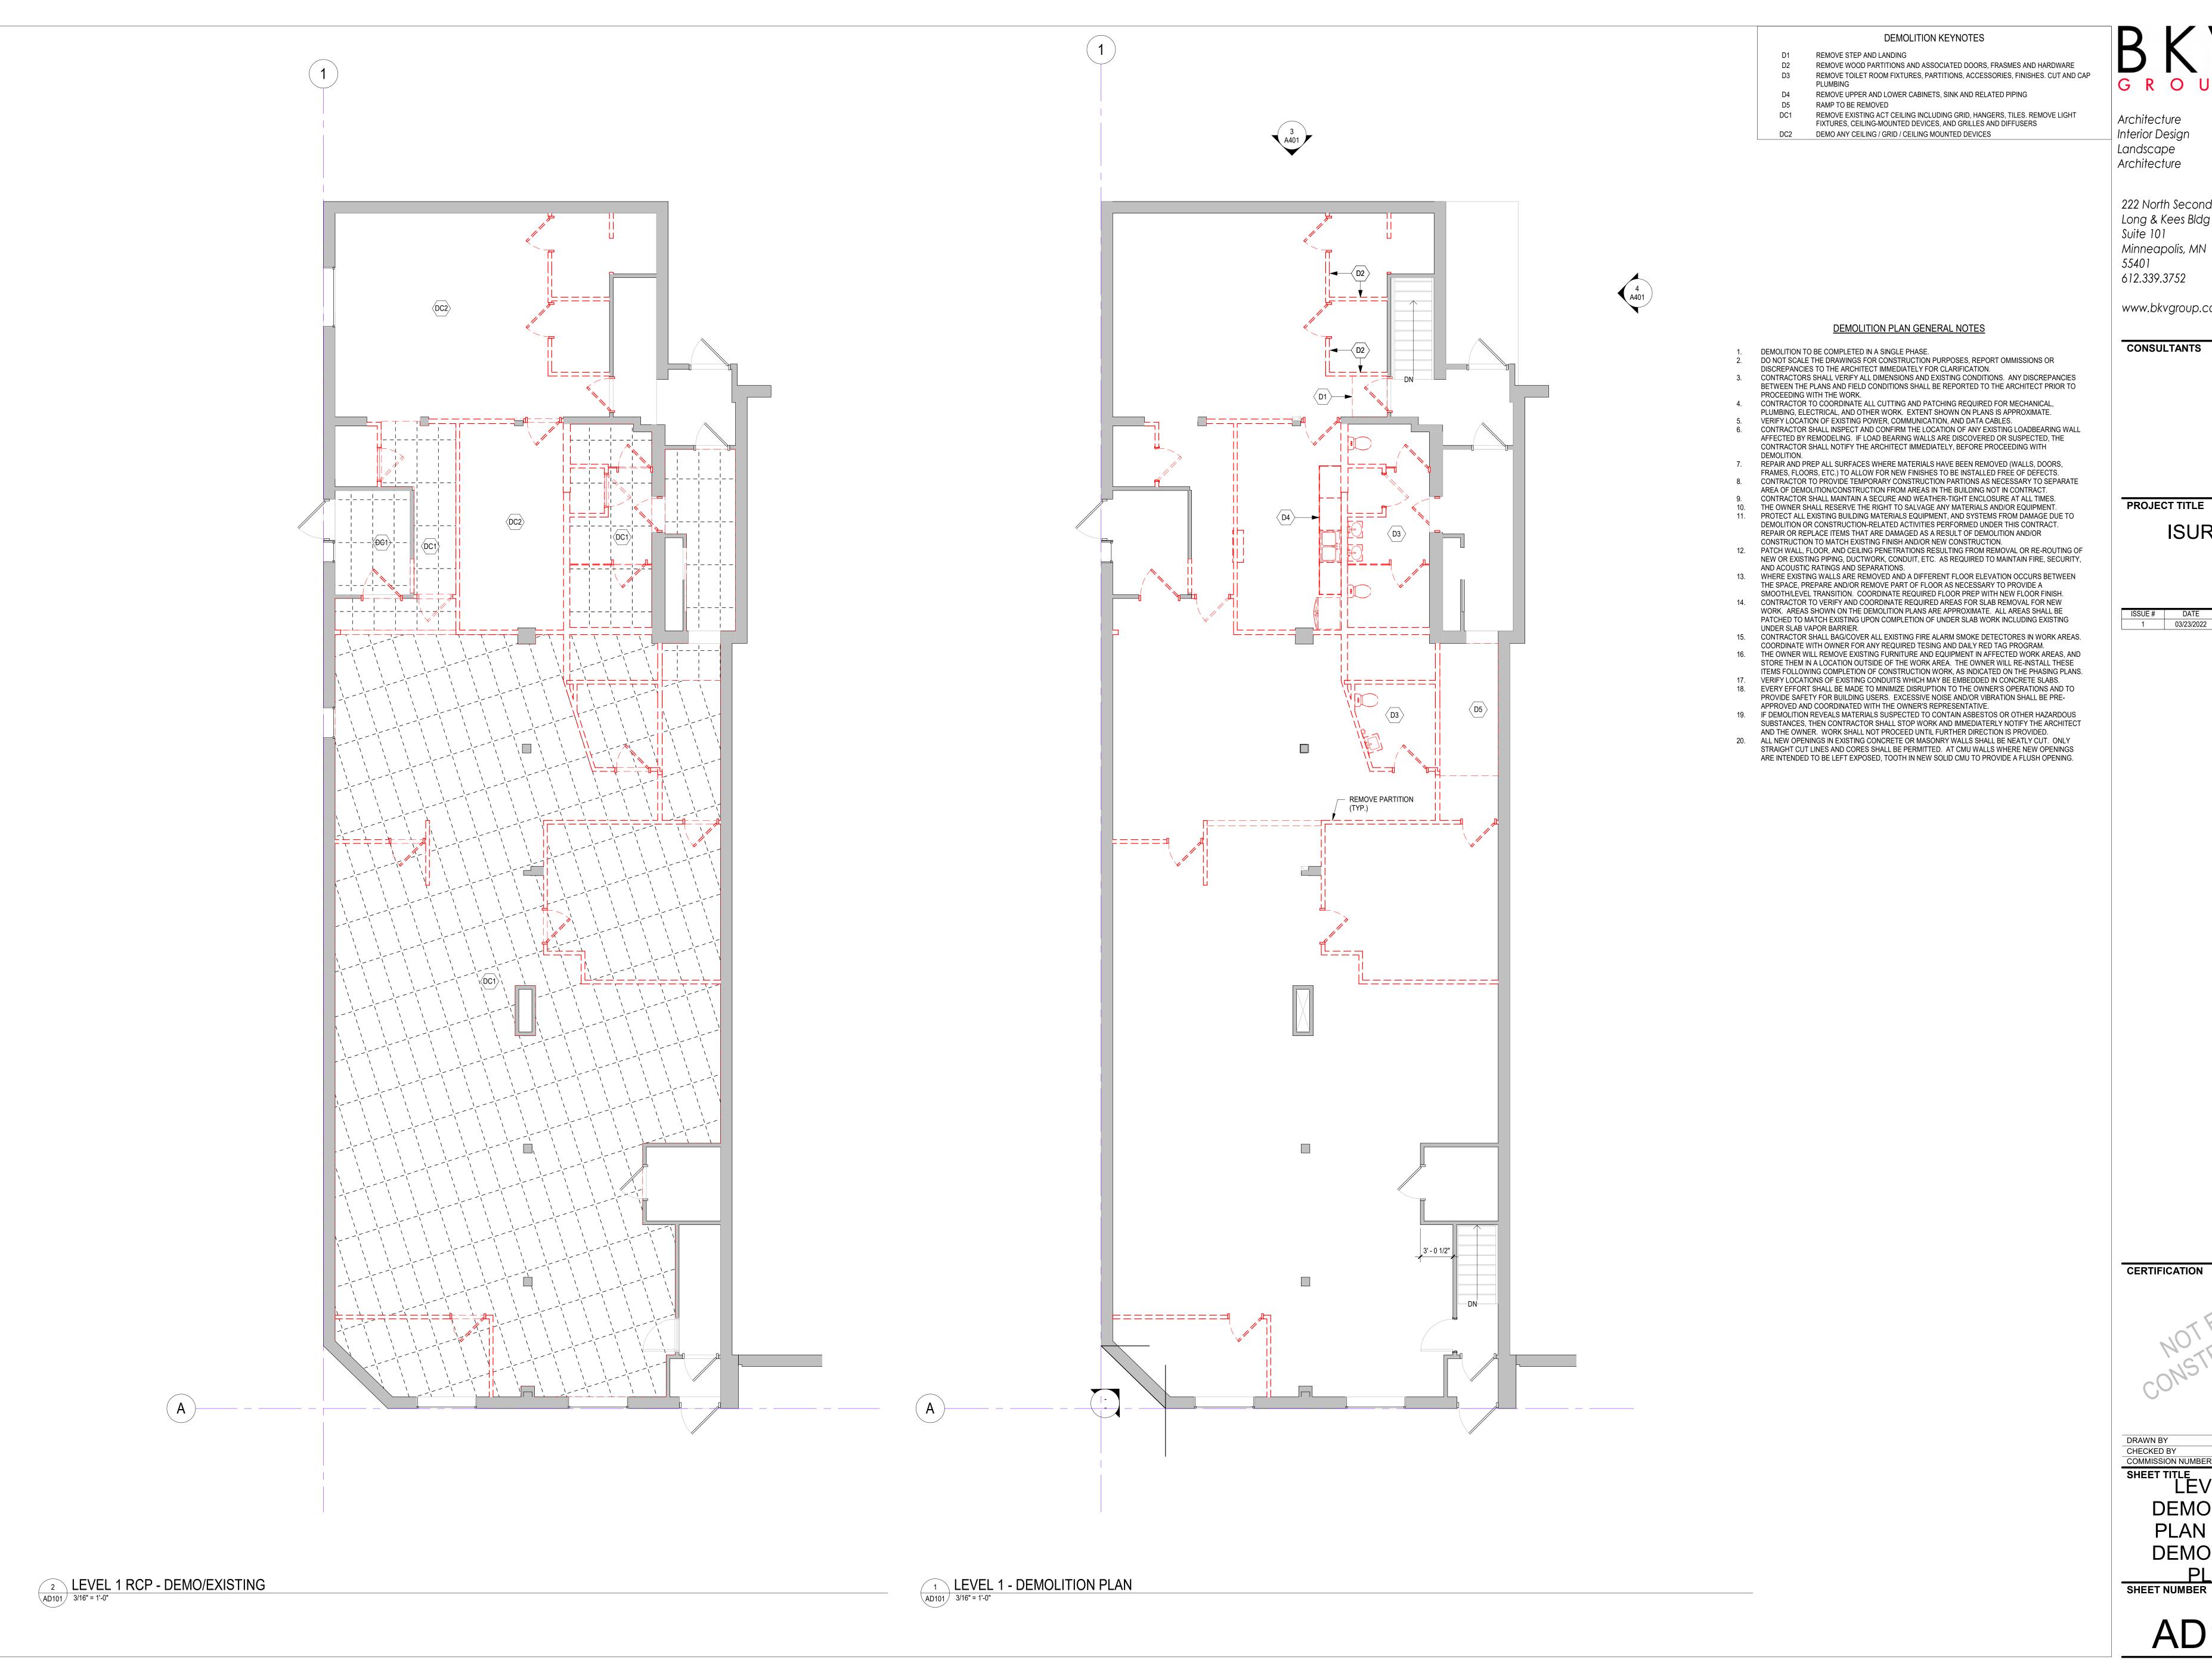

Architecture Interior Design Landscape

> 222 North Second Street Long & Kees Bldg Suite 101 Minneapolis, MN

www.bkvgroup.com

CONSULTANTS

ISUROON

1 03/23/2022 SCHEMATIC DESIGN

CHECKED BY COMMISSION NUMBER 2508.01

SHEET TITLE LEVEL 1 DEMOLITION PLAN & RCP **DEMOLITION** 

PLAN SHEET NUMBER

AD101

© 2021 BKV Group

Architecture
Interior Design
Landscape
Architecture

222 North Second Street Long & Kees Bldg Suite 101

Suite 101 Minneapolis, MN

612.339.3752

www.bkvgroup.com

CONSULTANTS

PROJECT TITLE

ISUROON

ISSUE # DATE DESCRIPTION

NOTFORTION

DRAWN BY
CHECKED BY
COMMISSION NUMBER

SHEET TITLE


LEVEL 1 -OVERALL RCP & FLOOR PLAN

SHEET NUMBER

© 2021 BKV Group

TRUE NORTH PLAN NORTI

A101

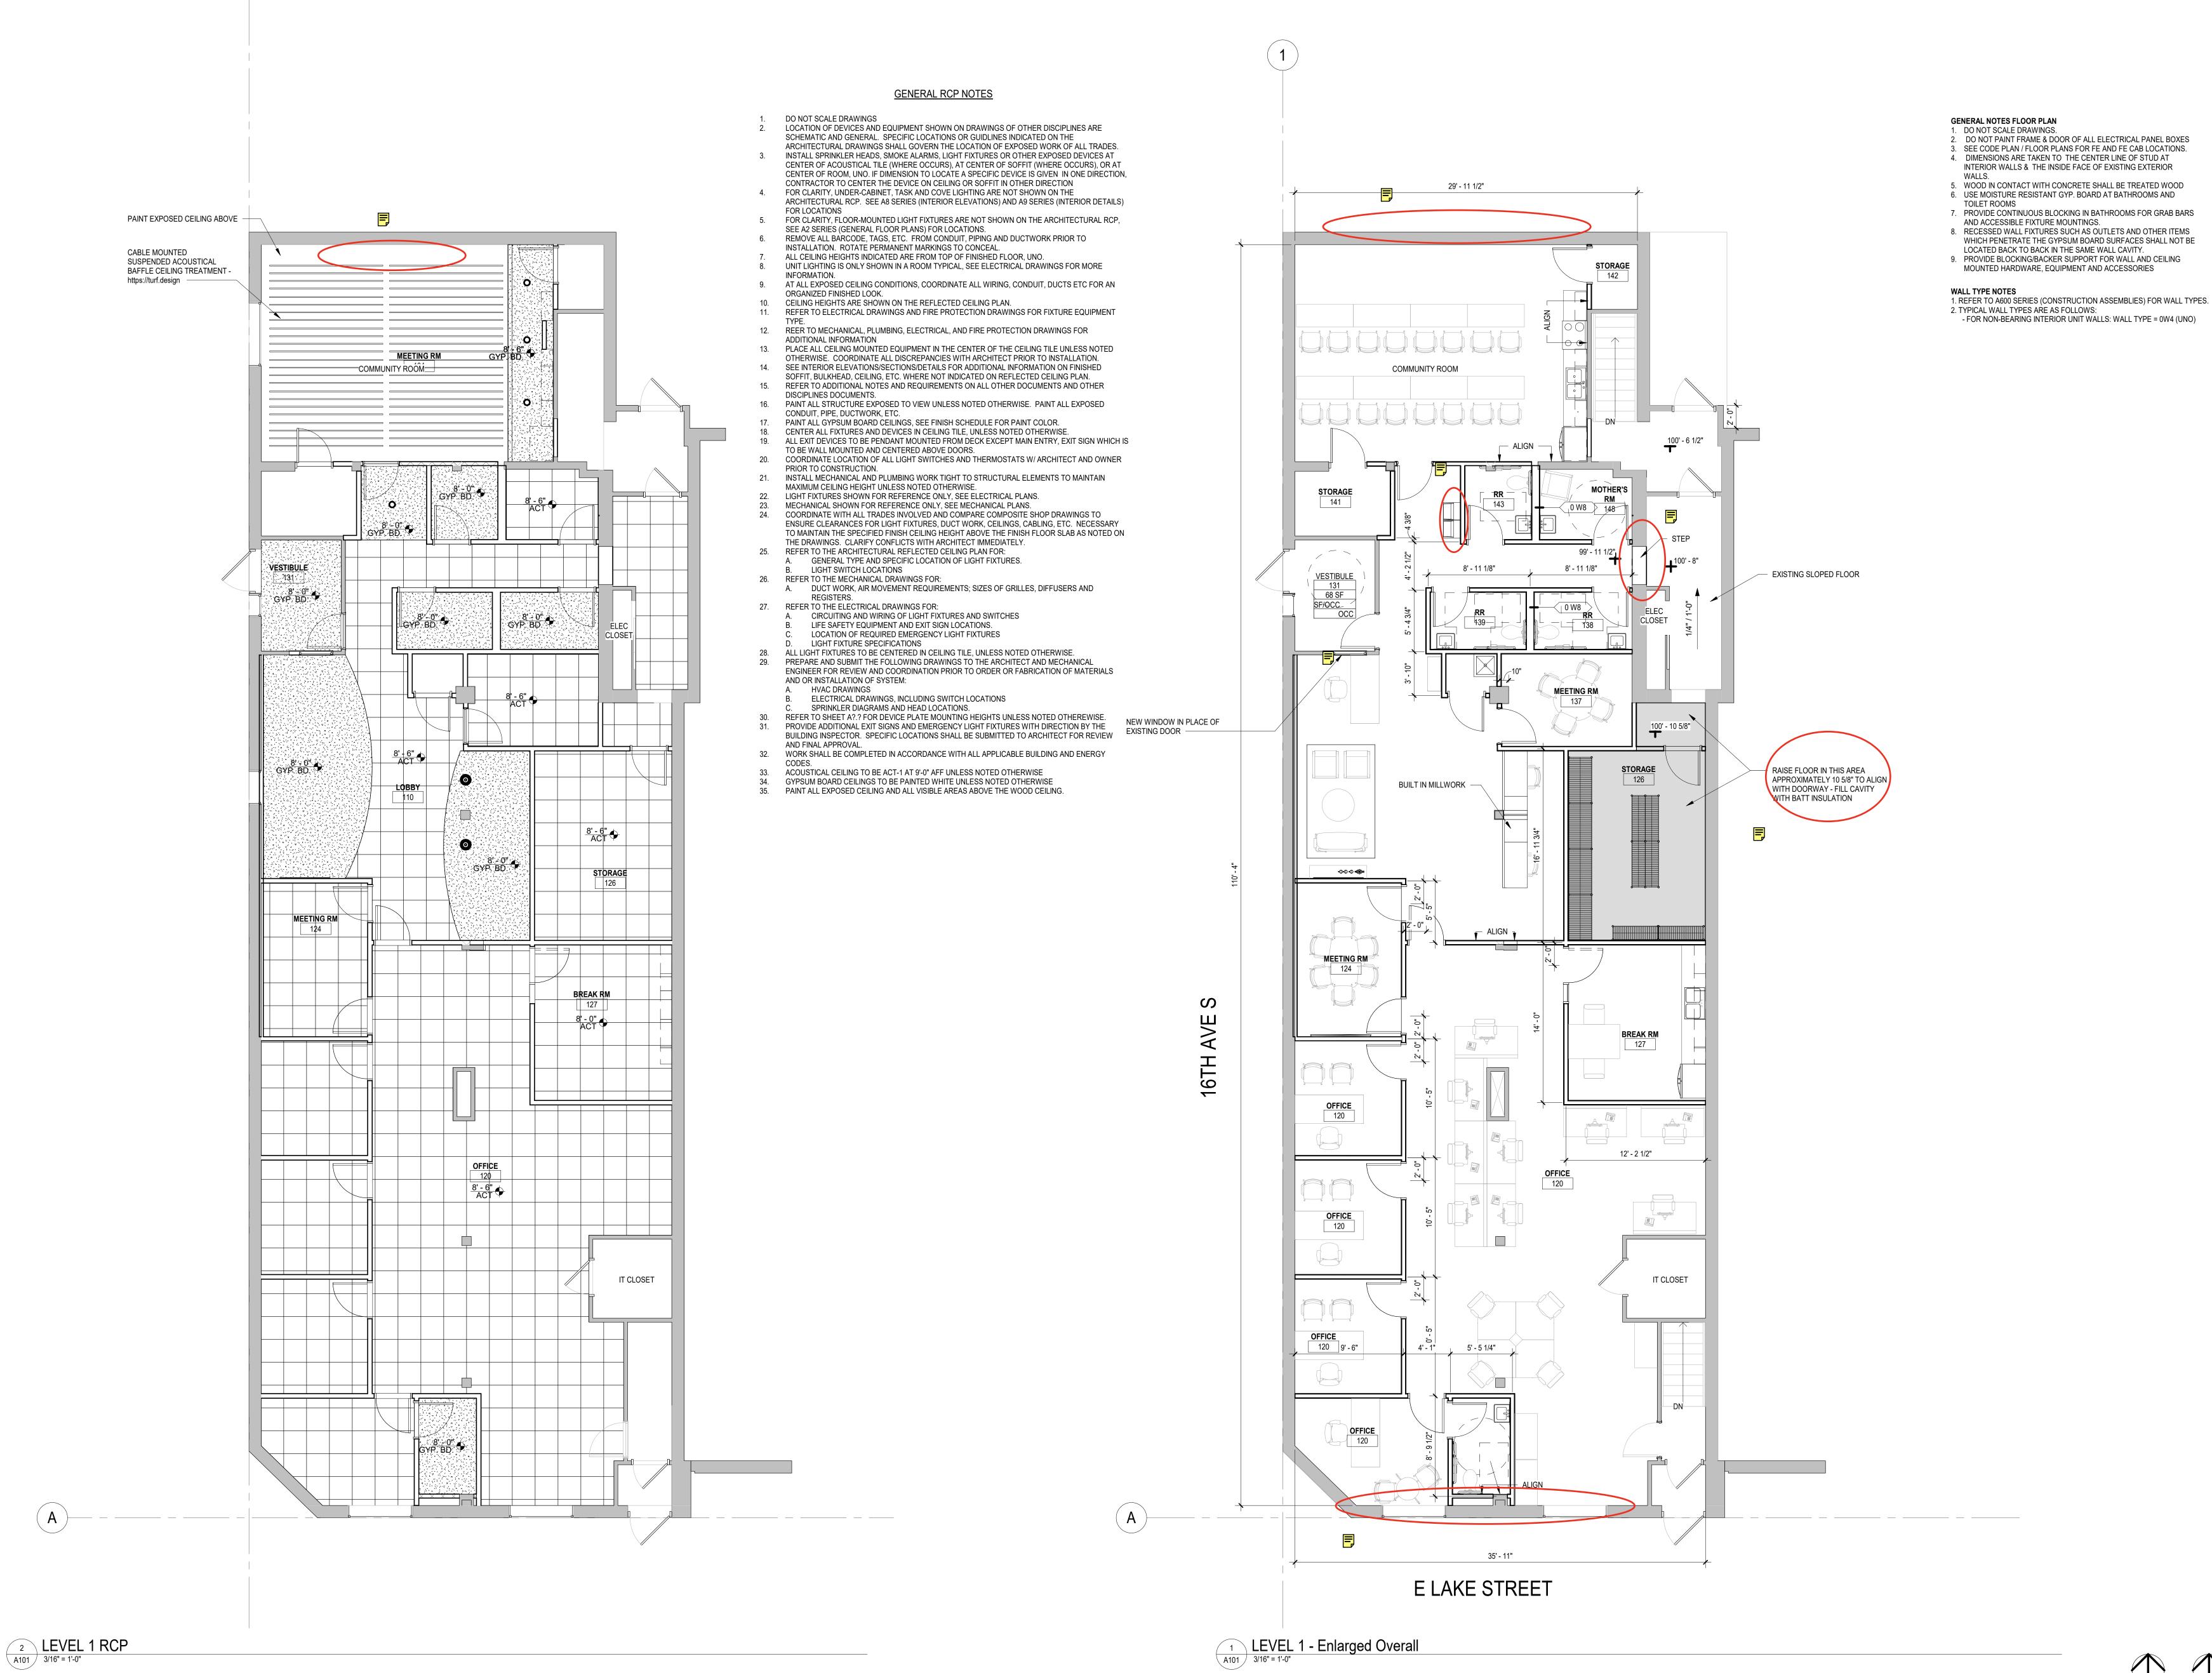

EXTERIOR ELEVATION KEYNOTES

E1 TYPICAL ALL FACES, REMOVAL OF FINISH PAINT TO SURFACE OF EXISTING BRICK
E2 50% TUCK POINTING
E3 NEW EXTERIOR PAINT
E4 FUTURE MURAL BY OWNER

Architecture Interior Design Landscape Architecture

> 222 North Second Street Long & Kees Bldg Suite 101 Minneapolis, MN 55401 612.339.3752

www.bkvgroup.com

CONSULTANTS

PROJECT TITLE

ISUROON

ISSUE # DATE DESCRIPTION
1 03/23/2022 SCHEMATIC DESIGN

DRAWN BY
CHECKED BY
COMMISSION NUMBER
COMMISSION NUMBER
COMMISSION NUMBER
COMMISSION NUMBER
COMMISSION NUMBER
COMMISSION NUMBER

**EXTERIOR ELEVATIONS** 

SHEET NUMBER

LEVEL 1 100' - 0"

91' - 8"

5 SECTION EAST-WEST
A401 1/8" = 1'-0"

Architecture Interior Design Landscape Architecture

222 North Second Street Long & Kees Bldg Suite 101 Minneapolis, MN 612.339.3752

www.bkvgroup.com

CONSULTANTS

PROJECT TITLE

ISUROON

ISSUE # DATE DESCRIPTION
1 03/23/2022 SCHEMATIC DESIGN

DRAWN BY ASW
CHECKED BY JH
COMMISSION NUMBER 2508.01 SHEET TITLE

CONSTRUCTION TYPES -PARTITION **TYPES** 

SHEET NUMBER

© 2021 BKV Group